
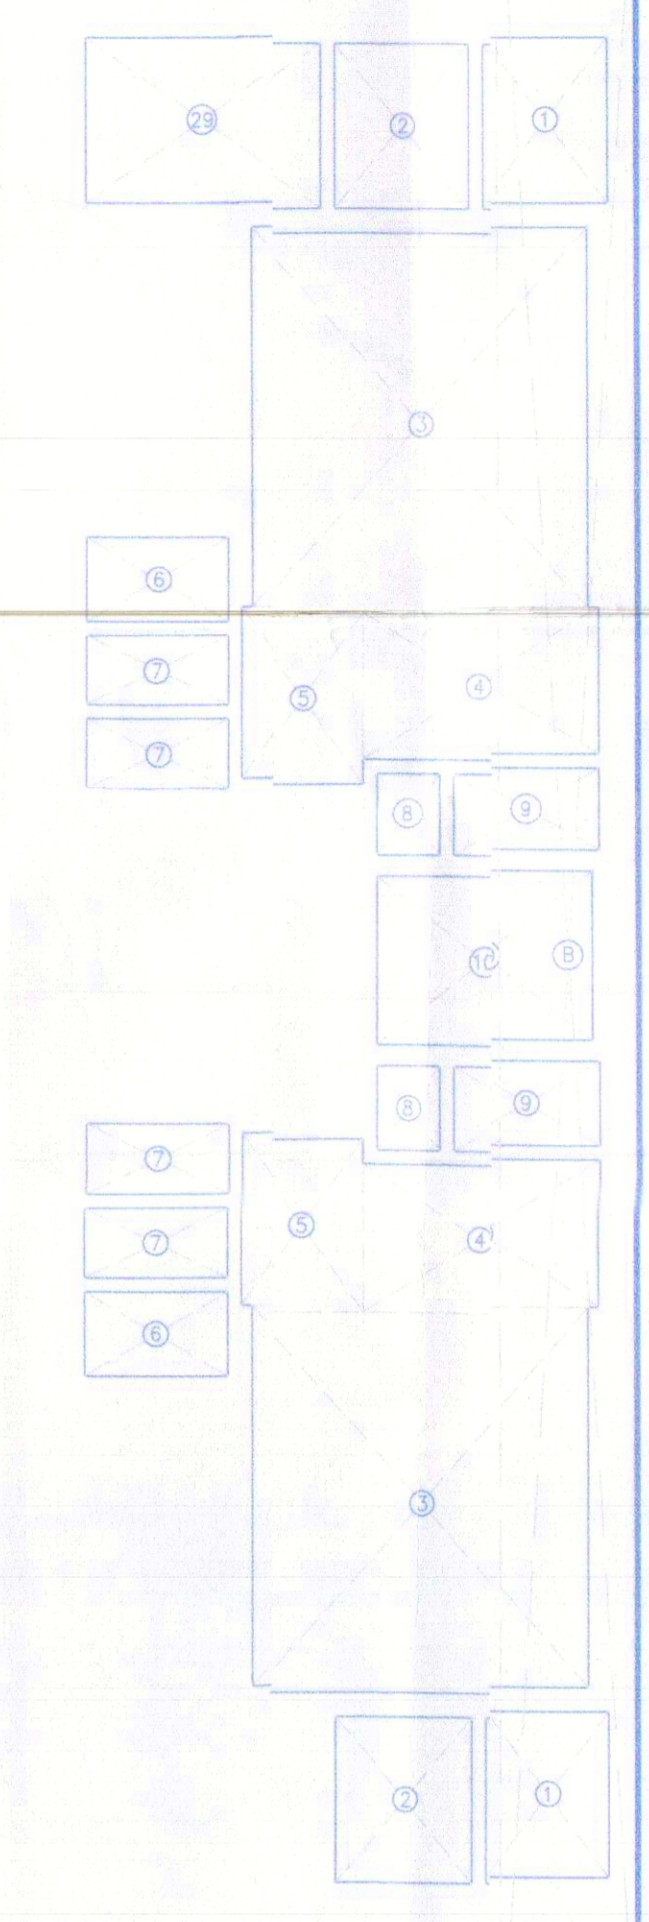
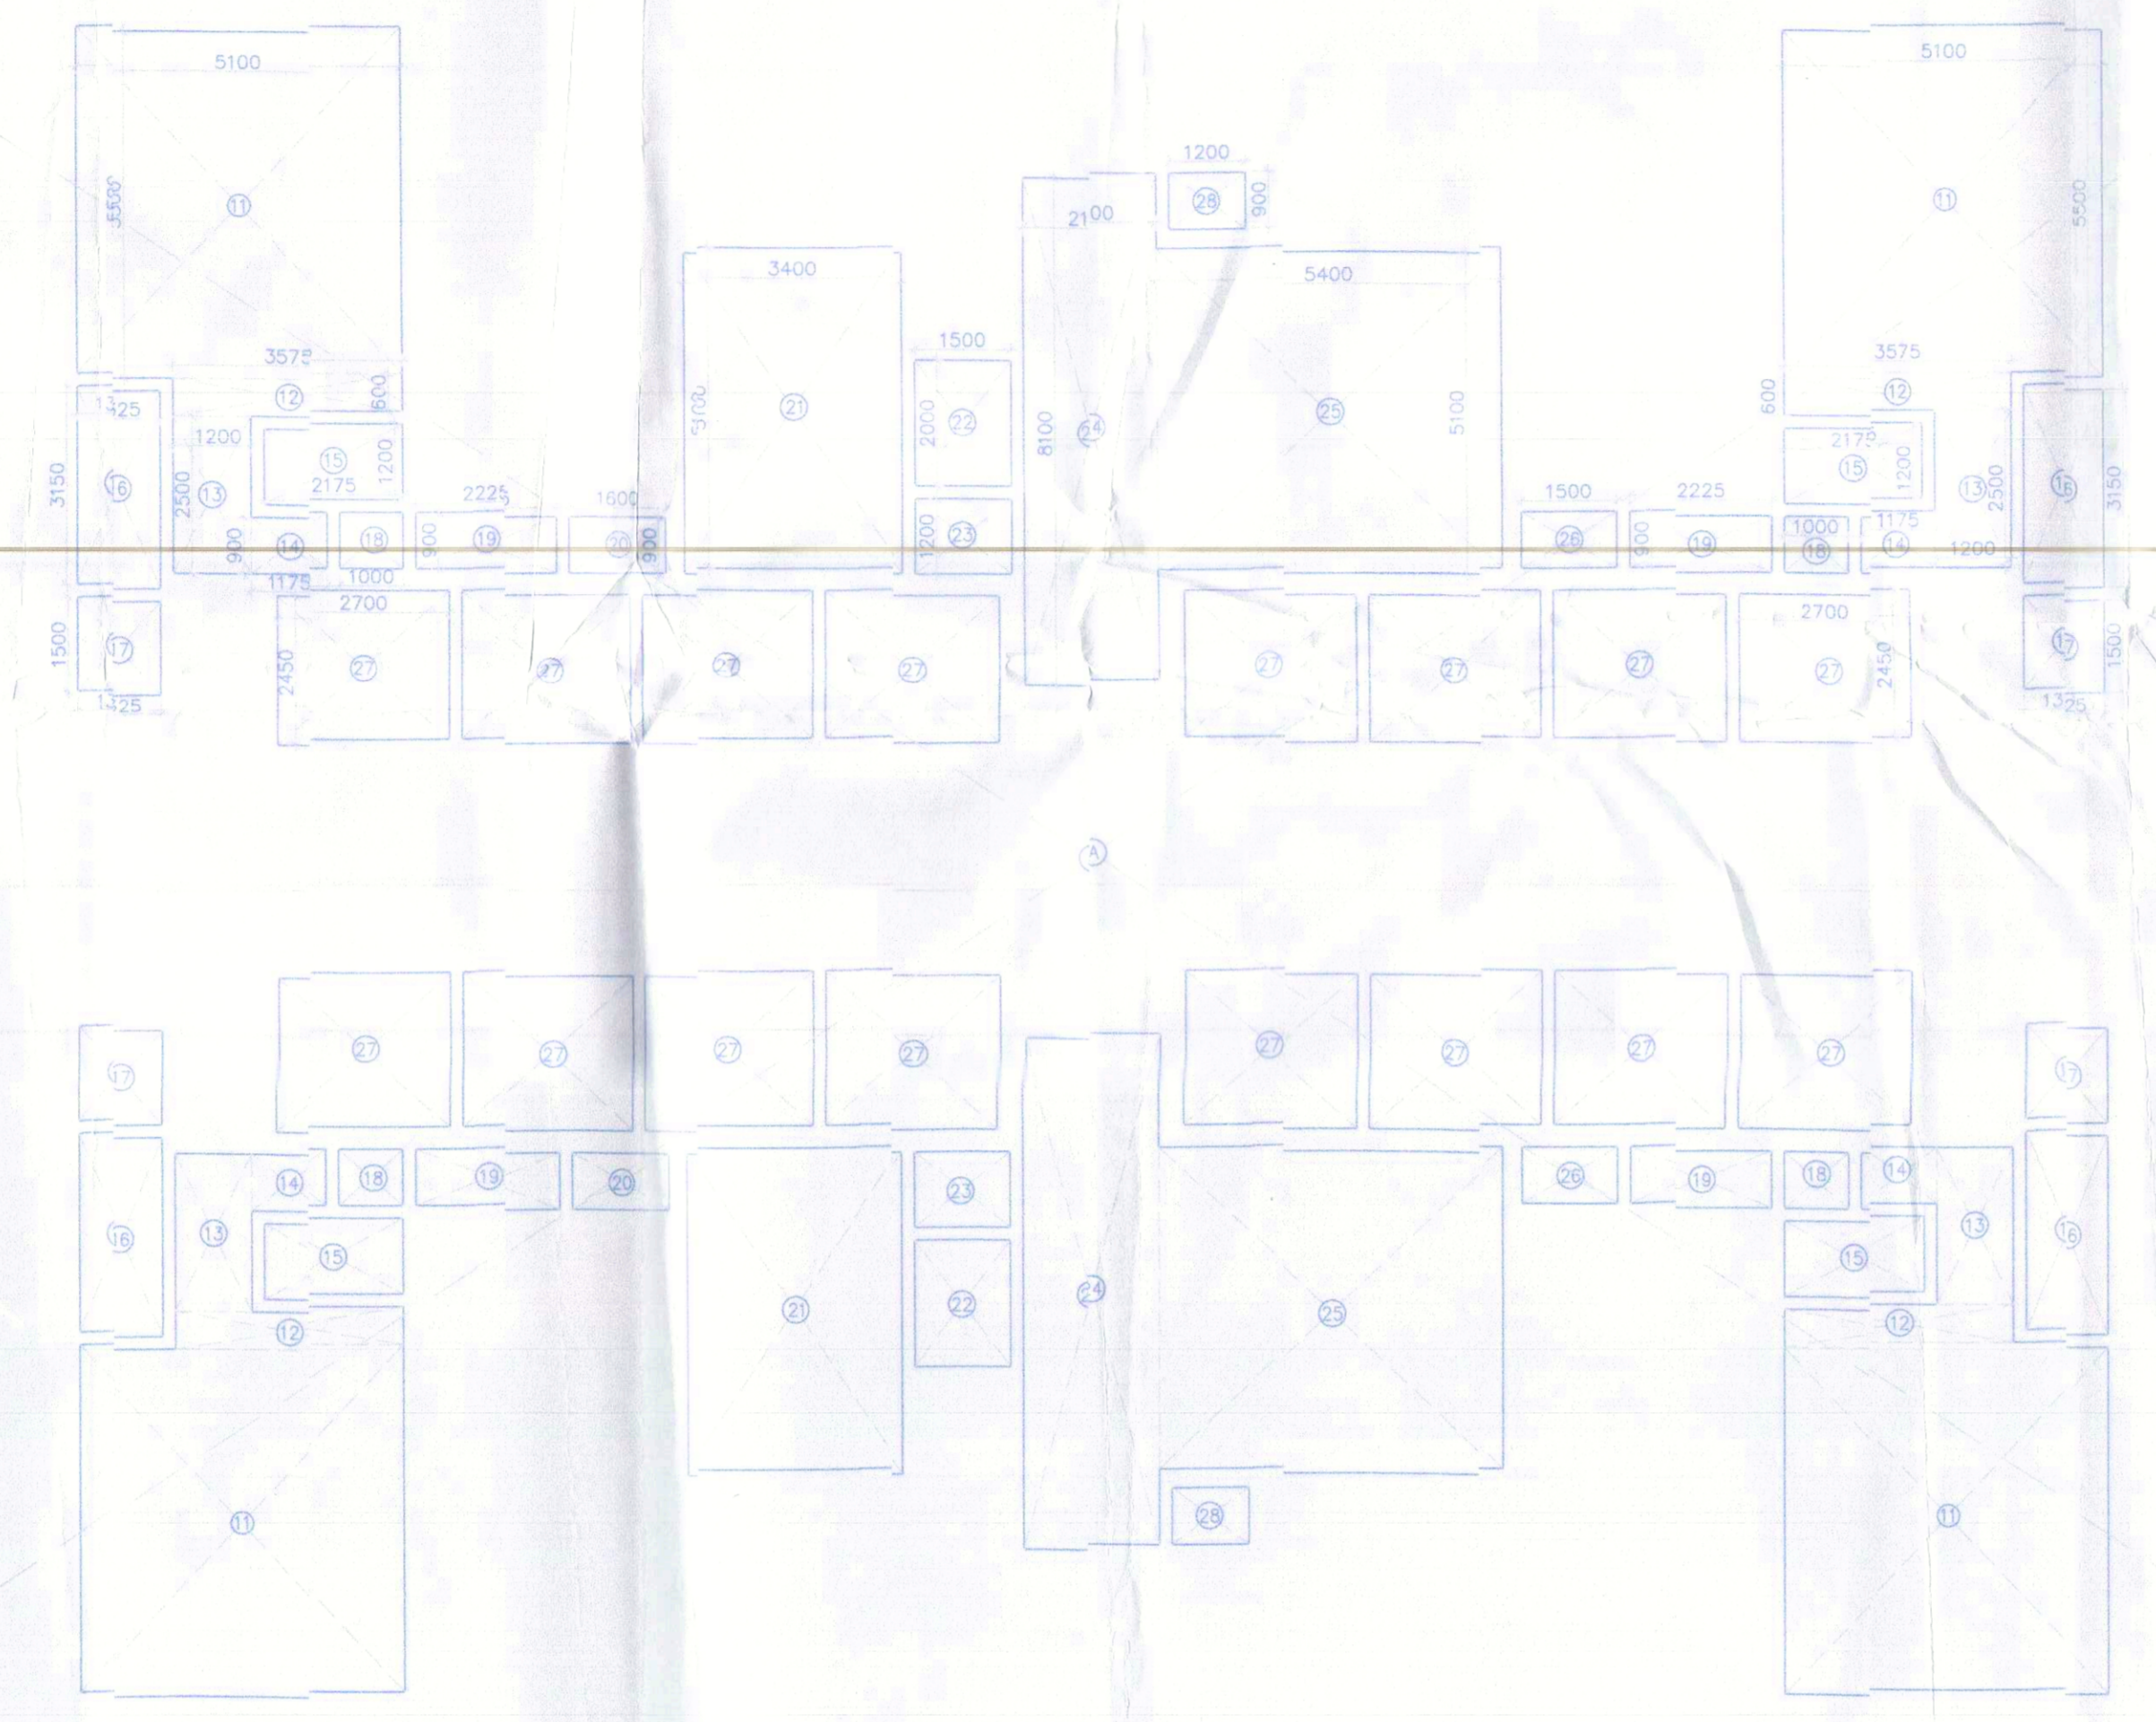


Note :-

1. BUILDING HAS AUTOMATIC SPRINKLER SYSTEM WHEREVER REQUIRED BY NBC.
2. BUILDING WILL BE DESIGNED (STRUCTURES) AS PER RELEVANT IS CODES FOR EARTH QUAKE RESISTANCE.
3. BUILDING IS ARTIFICIALLY LIGHTED MECHANICALLY VENTILATED & CENTRALLY AIRCONDITIONED WITH 100% POWER BACKUP

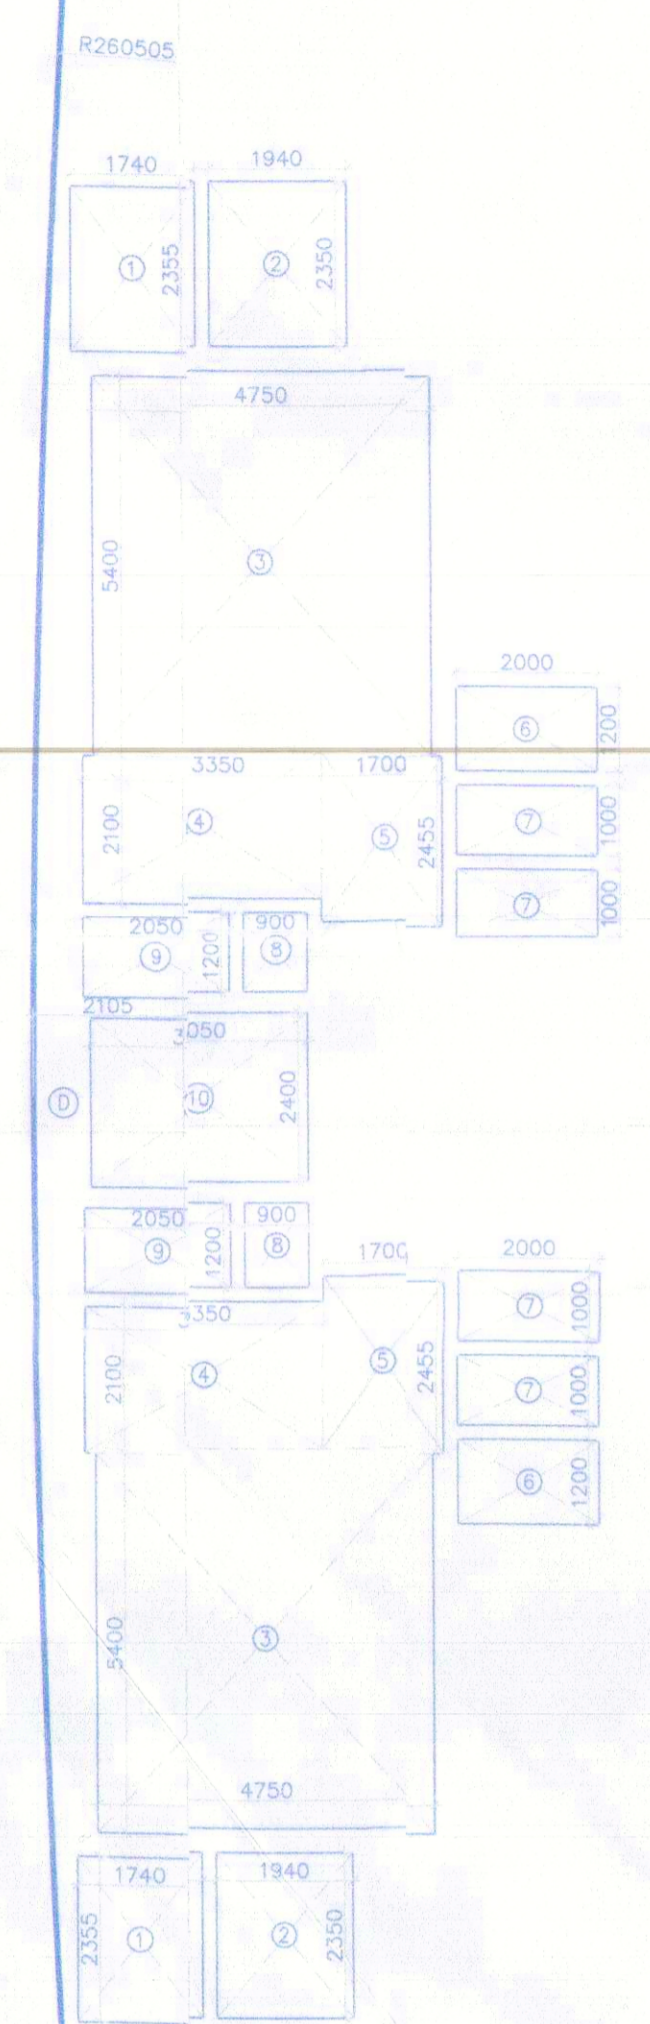

TYPICAL (2ND,3RD,4TH,5TH & 7TH,8TH,9TH) FLOOR BUILDING=2

TYPICAL (2ND,3RD,4TH,5TH & 7TH,8TH,9TH) FLOOR PLAN BUILDING=2											
GROSS - A											
NO.	AREA	PERIMETER	THICKNESS	CONCRETE	RAILING	STAIR	SHAFT	MECH	ELECTRICAL	MEASUREMENT	REMARKS
1	1740	1940	2300	100	100	100	100	100	100	100	100
2	2100	2300	2300	100	100	100	100	100	100	100	100
3	2100	2300	2300	100	100	100	100	100	100	100	100
4	2100	2300	2300	100	100	100	100	100	100	100	100
5	2100	2300	2300	100	100	100	100	100	100	100	100
6	2100	2300	2300	100	100	100	100	100	100	100	100
7	2100	2300	2300	100	100	100	100	100	100	100	100
8	2100	2300	2300	100	100	100	100	100	100	100	100
9	2100	2300	2300	100	100	100	100	100	100	100	100
10	2100	2300	2300	100	100	100	100	100	100	100	100
<b>TOTAL</b>	<b>17400</b>	<b>19400</b>	<b>23000</b>	<b>1000</b>	<b>1000</b>	<b>1000</b>	<b>1000</b>	<b>1000</b>	<b>1000</b>	<b>1000</b>	<b>1000</b>

TOTAL FAR AREA OF TYPICAL (2ND,3RD,4TH,5TH & 7TH,8TH,9TH) BUILDING =	GROSS - A =	GROSS - B =	GROSS - C =
6288.89 SQM	6874.410	359.353	674.954

Project Name: **NEHA CHANDEL**  
 Location: **NEHA CHANDEL**  
 Date: **22-08-2019**

TYPICAL 2ND,3RD,4TH,5TH & 7TH,8TH,9TH AREA BUILDING=2			
NO.	AREA	PERIMETER	REMARKS
1	1740	1940	16.391 SQM
2	2100	2300	18.736 SQM
3	2100	2300	102.000 SQM
4	2100	2300	28.140 SQM
5	2100	2300	16.694 SQM
6	2100	2300	9.600 SQM
7	2100	2300	16.500 SQM
8	2100	2300	4.320 SQM
9	2100	2300	9.840 SQM
10	2100	2300	14.640 SQM
11	2100	2300	112.200 SQM
12	2100	2300	8.560 SQM
13	2100	2300	12.000 SQM
14	2100	2300	4.230 SQM
15	2100	2300	10.440 SQM
16	2100	2300	16.695 SQM
17	2100	2300	7.960 SQM
18	2100	2300	3.600 SQM
19	2100	2300	8.010 SQM
20	2100	2300	2.880 SQM
21	2100	2300	34.500 SQM
22	2100	2300	6.000 SQM
23	2100	2300	3.600 SQM
24	2100	2300	34.500 SQM
25	2100	2300	55.080 SQM
26	2100	2300	2.700 SQM
27	2100	2300	105.840 SQM
28	2100	2300	2.180 SQM
29	2100	2300	7.779 SQM
<b>TOTAL</b>	<b>17400</b>	<b>19400</b>	<b>674.954</b>



RISMS ARCHITECTS PVT. LTD.  
 69, Naga Niwas, Bhawani Kunj  
 (Behind D2), Vasant Kunj,  
 New Delhi-110070.  
 Tel: 011-26898816, 26898617  
 www.risms-arch.com

PROPOSED SUBMISSION OF UNDER TRANSIT ORIENTED DEVELOPMENT (TOD) POLICY FOR COMMERCIAL SITE MEASURING 32.36 ACRES FALLING IN RESIDENTIAL PLOTTED COLONY NAMEDLY DLF CITY, PHASE-I, II & III IN SECTOR-24, 25 & 25A CURUGRAM-MANE SAR URBAN COMPLEX BEING DEVELOPED BY DLF LIMITED.

OWNER: **DLF CITY CENTRE LTD.**  
 (THE SHOPPING MALL COMPLEX, ARUN MARG, DLF CITY, PHASE-I, GURGAON - 122002, HARYANA)

DRAWING TITLE: **AREA CALCULATION OF 2ND, 3RD, 4TH, 5TH, 7TH, 8TH, 9TH SECT**

Scale: 1:100  
 Date: 22-08-2019  
 Project No: 82-09A  
 Revision: 1

Architect's Seal & Signature: **RISMS ARCHITECTS**  
 Owner's Seal & Signature: **DLF CITY CENTRE LTD.**